
James Barr

APPLICATION PLANS & DOCUMENTS

APPLICATION REF: 10/02077/PP - LAND NORTH WEST OF COLINTRAIVE

- SITE LOCATION PLAN, SCALE 1:10000
- LOCATION PLAN, SCALE 1:1250. DRAWING NO. 1246 LP1 A
- SITE PLAN AS EXISTING, SCALE 1:200. DRAWING NO. 1246 SP1 A
- SITE PLAN AS PROPOSED, SCALE 1:200. DRAWING NO. 1246 SP2 B
- ELEVATION/FLOOR PLANS, DESIGN NO. 3A, SCALE 1:100. DRAWING NO. 1246 p01b
- PHOTOGRAPH OF PROPOSED WOODEN GATES
- DESIGN STATEMENT, PREPARED BY HOUSTON ARCHITECTS

Nicholas Staunton Proposed New House at; Site to North West of Ardare, Colintraive.

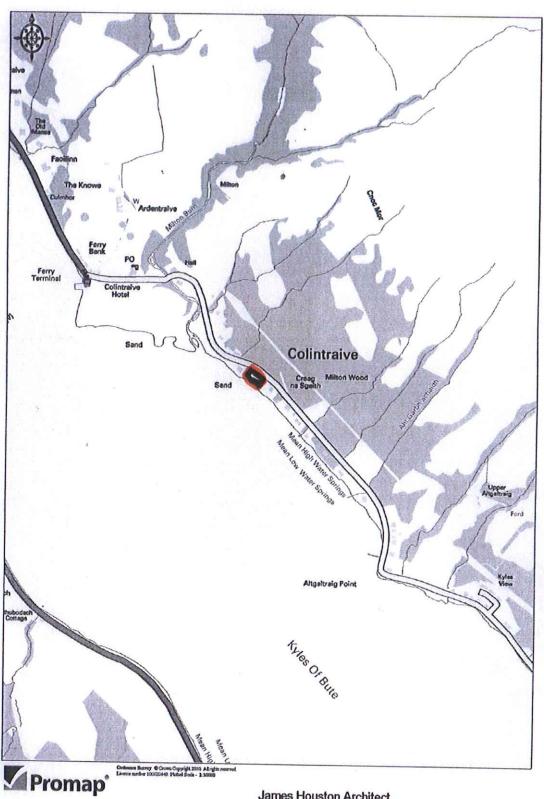



James Houston Architect

SCALC 1:10000



Nicholas Staunton
Proposed New House at:
Site to North West of
Ardare, Colintraive.
PA22 3AS.

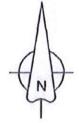

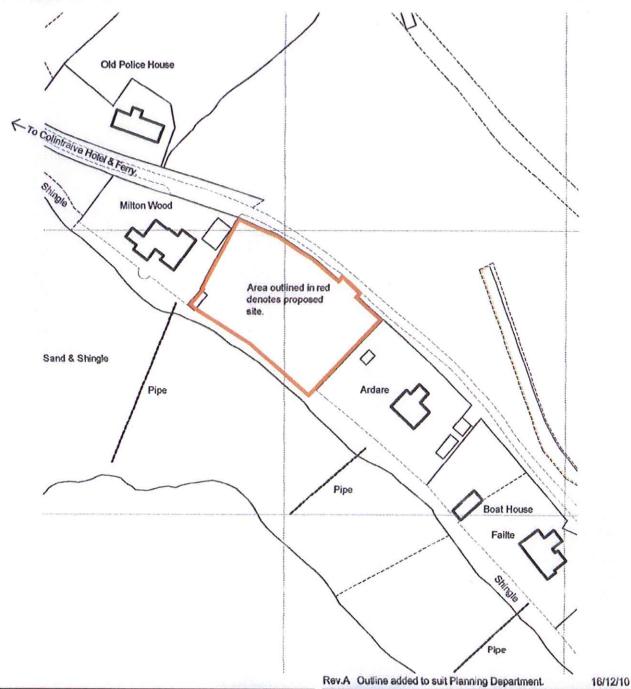





JAMES HOUSTON Architects


2, Schoolwynd, Kilbirnie, Ayrshire, KA25 7AY Tel: 01505 682203 E-mail: mail@houstonarchitects.co.uk

	A STATE OF THE PARTY OF THE PAR	
Drwg. Title		
Location I	Plan	
	Contractive of the second	
Scale 1:1250	Drwg. No.	
Date 22nd Nov. 10	1246 - LPI A	1



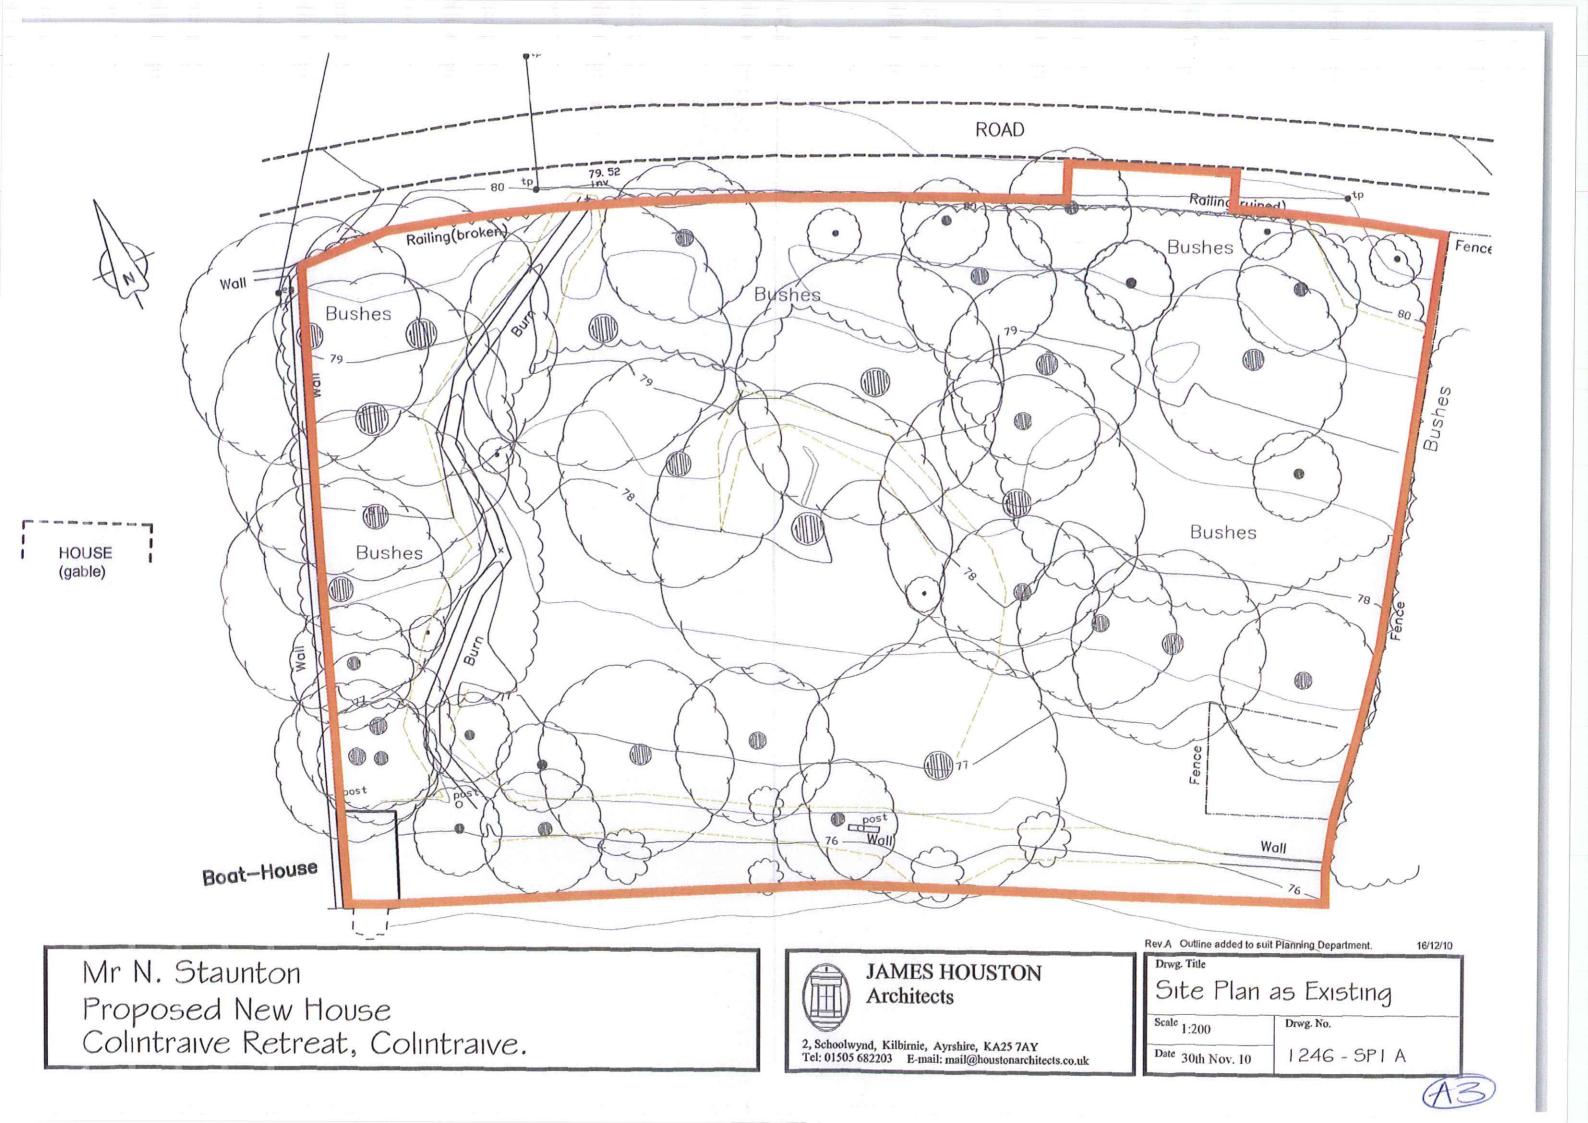

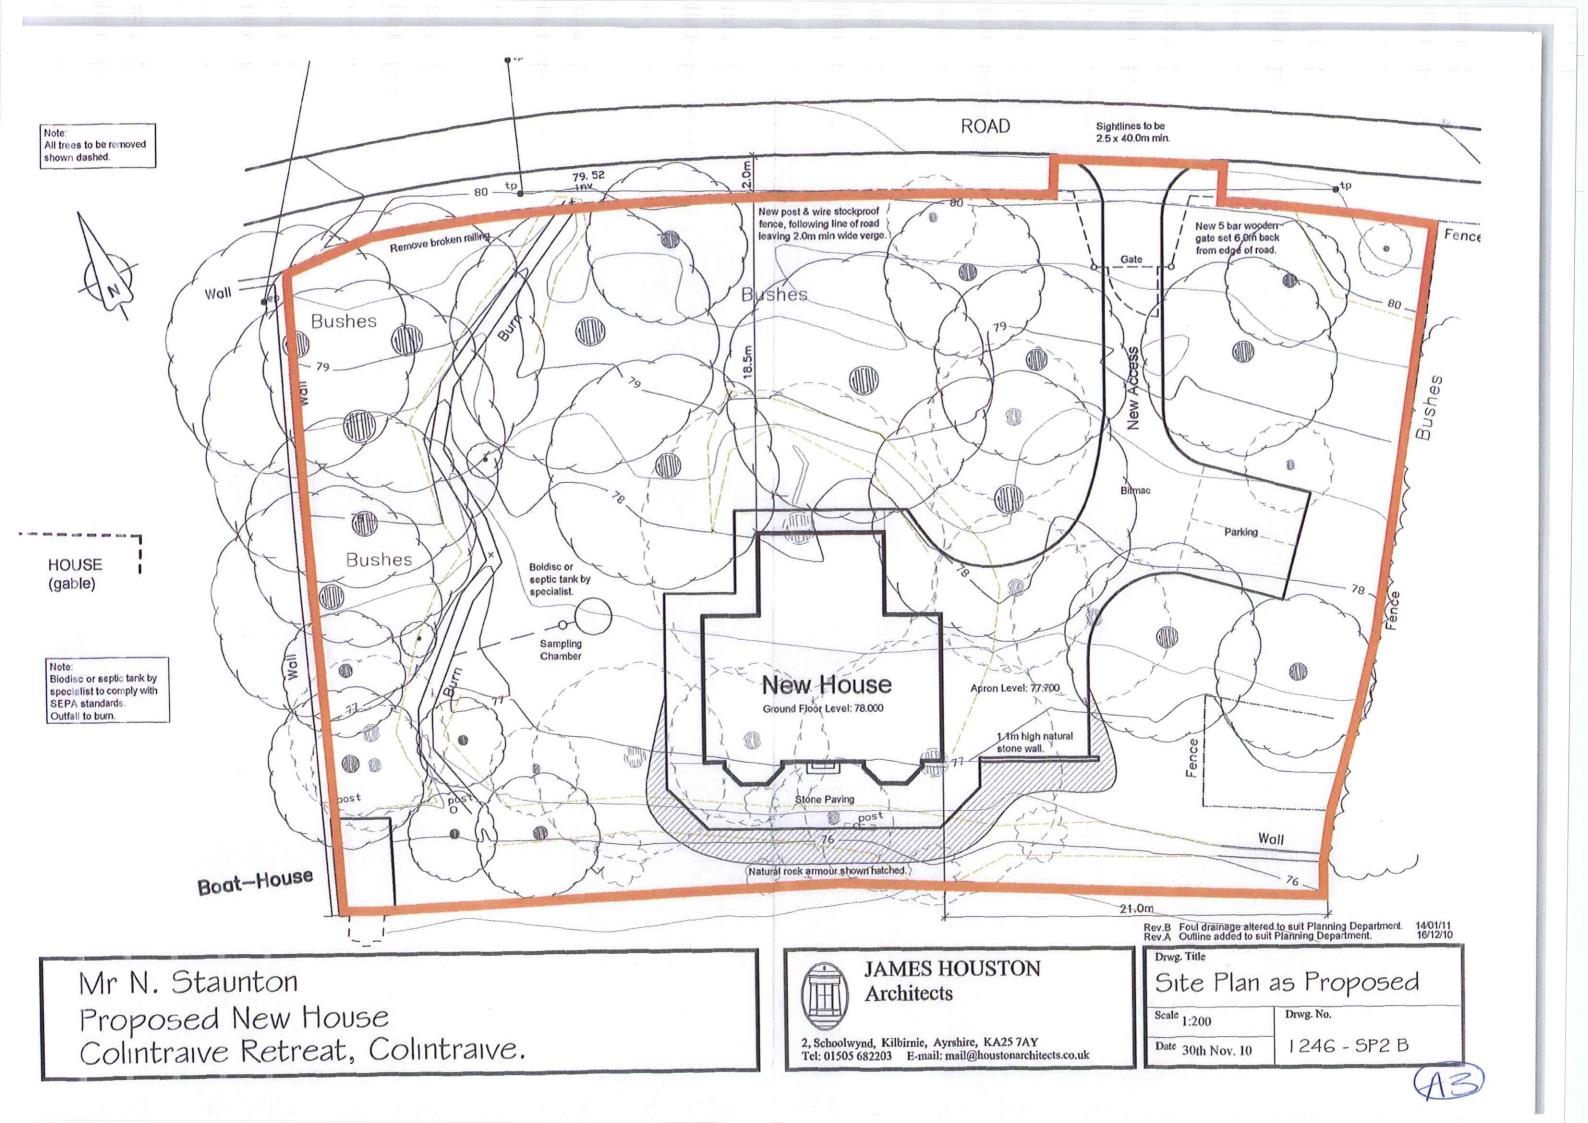

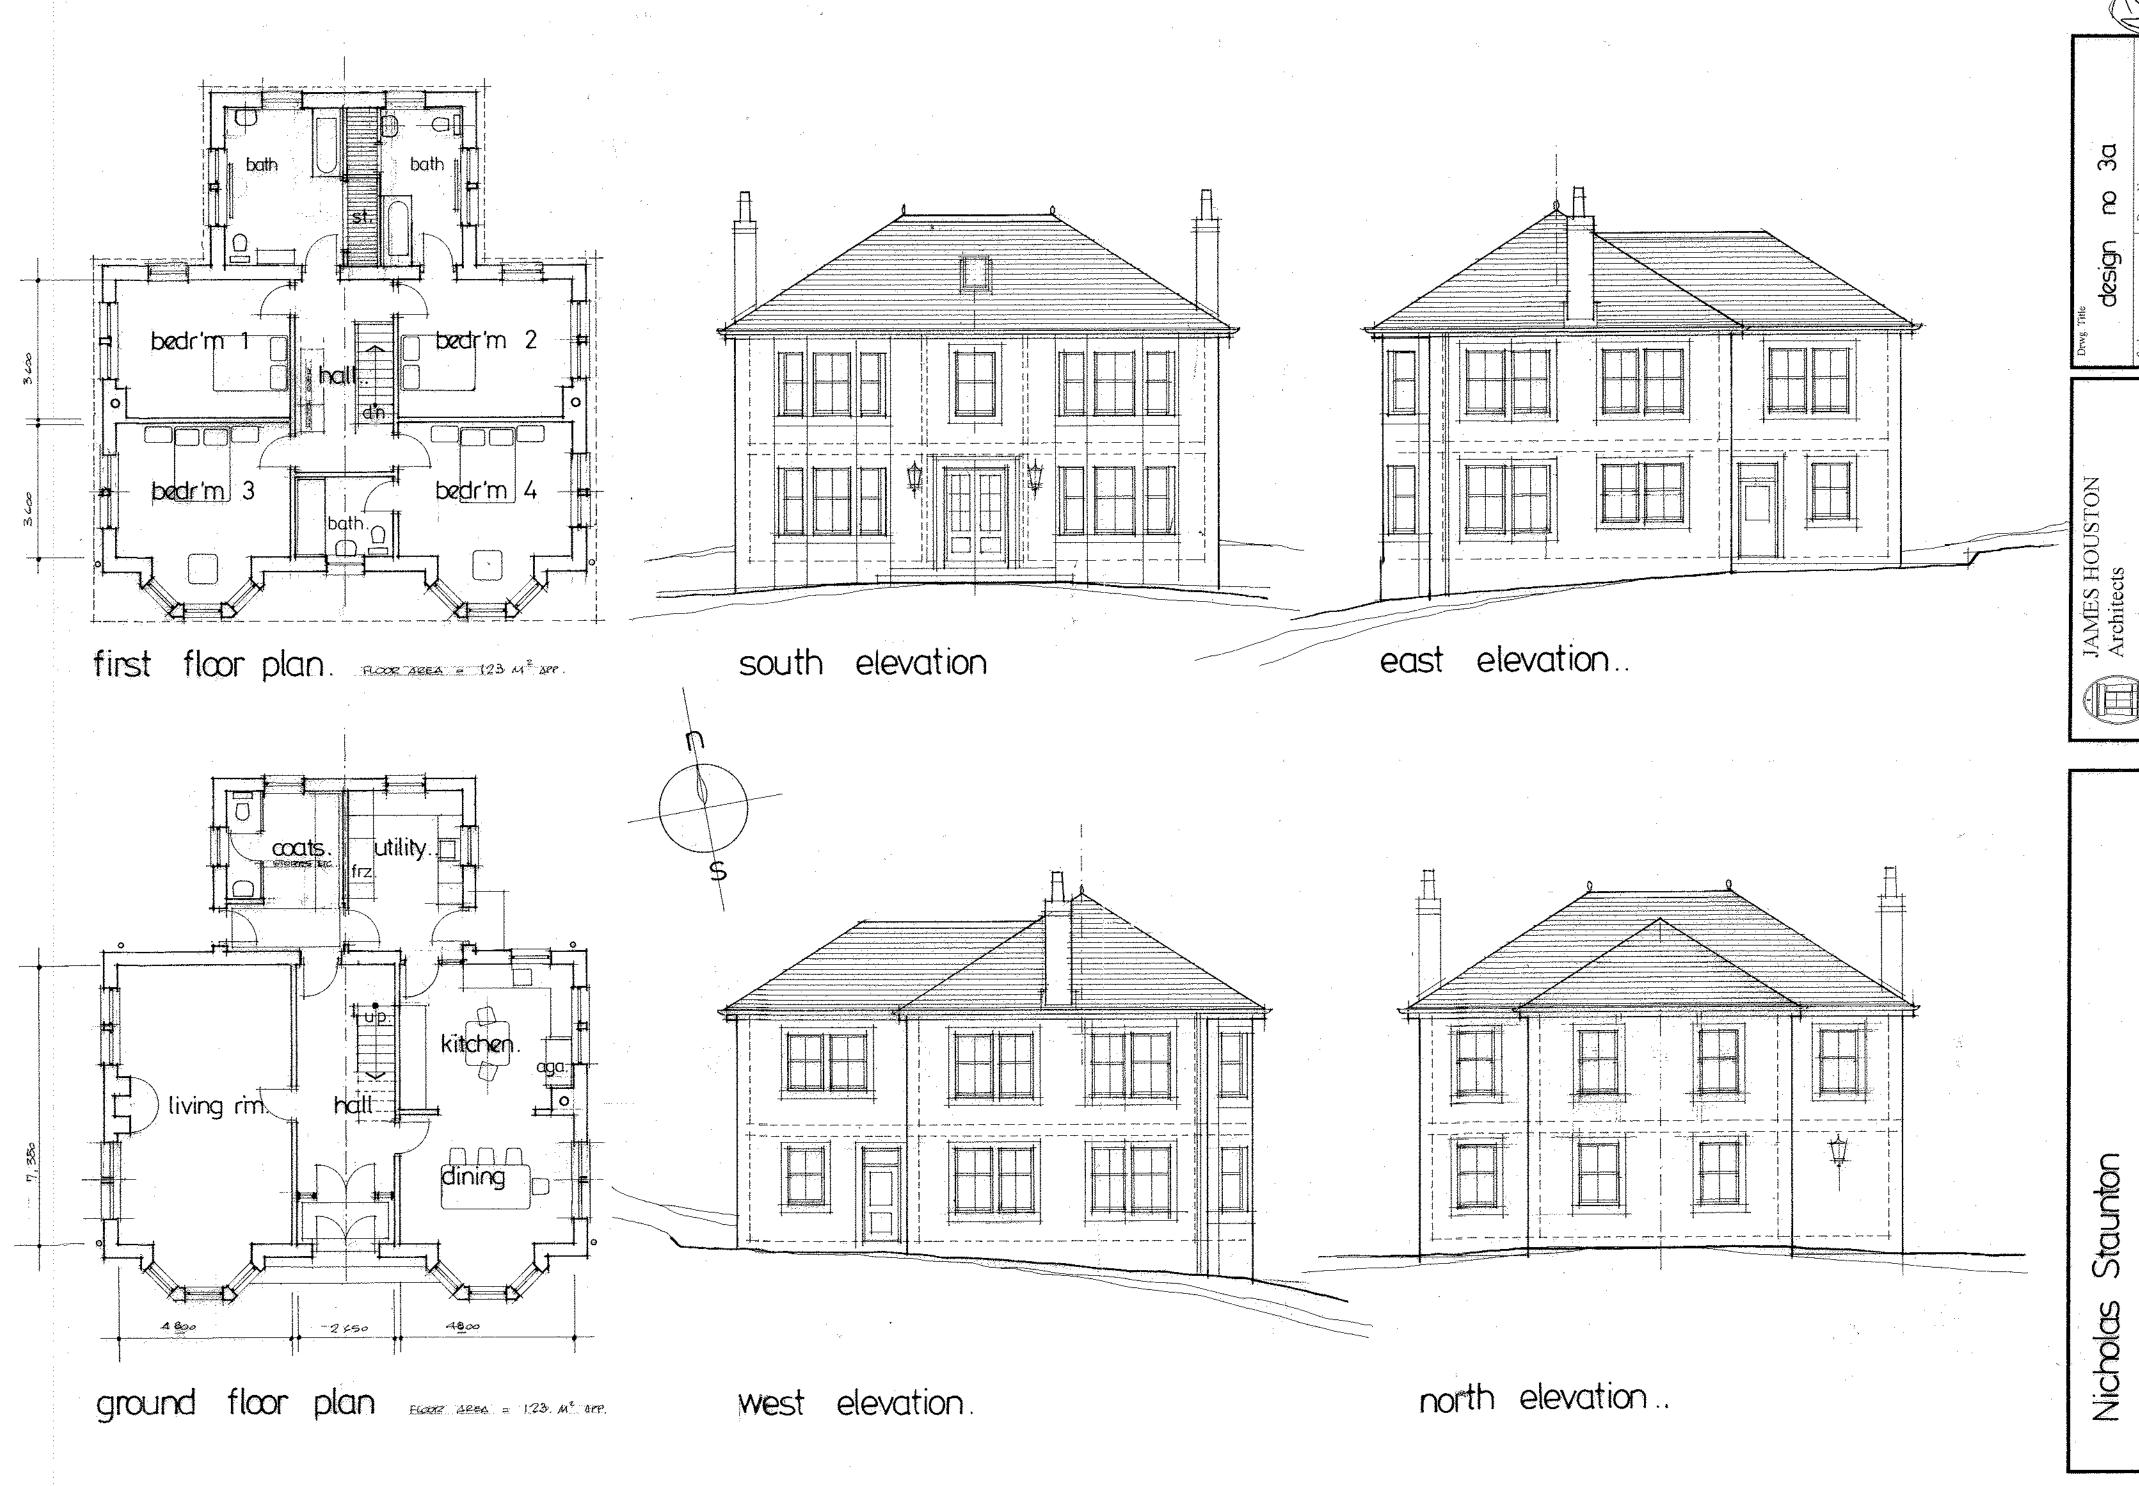

at Colintraive...





Proposed House on site North West of Ardare, Colintraive.

Design Statement

Site Considerations:

A detailed topographical survey has been carried out showing the contours of the site and the position of all mature trees. It is intended to preserve as many of these trees as possible in order to maintain the well furnished character of the site.

The enclosed drawings 1246 SP1 and SP1A, illustrate the site as it exists at the moment and also as it would be with the proposed new house carefully located to minimise disturbance of the trees and natural appearance of the site.

Design Principles:

The client brief requires a fairly large family house to provide living accommodation for the large family and with adequate accommodation for friends and relatives who would visit the house mainly (but not only) during the summer months.

In consideration of the nature of the site it is recognised that although the overall area of the site is quite extensive, the footprint of the building should be kept to a minimum, so that a minimum number of trees have to be disturbed. Consideration should be given to the architectural style of existing buildings adjacent to the site, particularly Ardare to the South-East.

Proposed Solution:

In order to provide a workable solution to the accommodation requirements it is proposed to form a two storey house in relatively compact form. The character of the existing Ardare House with its piended natural slated roof and vertical proportioned windows has been taken into consideration. See attached photographs.

As at Ardare the proposed design also has a natural slate piended roof and vertical proportioned windows set in traditional ivory roughcast walls.

The access will be formed with 2.4m x 40.0m visibility splays and a traditional 5 bar gate set 6.0m back from edge of road. The access road will be formed to curve between existing trees and will be surfaced with plain kerbless bitmac. A plain stockproof stob and wire fence is proposed along the frontage to the main road

James Houston Architect

1st December 2010

Attached:

Photographs of Ardare from West (Garden) Photographs of Ardare from West (Seaside)